

## BUILDING NOTES

- 1) Interior Lighting Systems Interior lighting systems throughout is to comply with AS 1680 (As required by BCA CL 3.8.4.3 class 1 & 10 buildings and CL F4.1, F4.2, F4.3, F4.4 for class 2 to 9 buildings
- 2 to 9 buildings All sanitary compartments are to be constructed to comply with BCA Part3 CL 3.8.3.3 for class 1, & 10 buildings and CL F2.5b for class Sanitary Compartments
- Smoke detectors shall be installed within the building in accordance with AS 3786 (As required by BCA Part 3.7.2 3) Smoke Detectors
- All balustrades (if required) heights and design shall be in accordance with AS 1170 Pt 1 (As required by BCA Part 3 Cl 3.9.2.3 for class 1 & 10 buildings and BCA Part D CL D2.16 for class 2 to 9 buildings Balustrades

WATER

SHOWER HEAD RATING

TOILET FLUSHING

RATING

4 star (> 4.5 4 star

but <=

6 L/min)

KITCHEN TAP FITTINGS RATING : BATHROOM TAP FITTIND RATING :

5) All aluminium framed glazing is to comply with AS 1288, AS 2208

STORMWATER

BASIX

**NFORMATION** 

RAINWATER TANK RAINWATER USE :

ABOVEGROUND =2000L

THE RAINWATRE MUST COLLECT AT LEAST 60 SQUARE METRES OF THE ROOF AREA. THE APPLICANT MUST CONNECT THE RAINWATER TANK TO:

AT LEAST ONE ORECOMMEND TO POTABLE WATE

: OUTDOOR TAP IN THE DEVELOPMENT (NOTE: NSW HEALTH DOES NOT THAT RAINWATER BE USED FOR HUMAN CONSUMPTION IN AREAS WITH


ALL TOILETS IN THE DEVELOPMENT THE COLD WATER TAP THAT SUPPLI

TER TAP THAT SUPPLIES EACH CLOTHES WASHER IN THE

ER SUPPLY.)

DEVELOPMENT

6)Termite Control KORDON TERMITE builder is to provide all relevant slab or BARRIER is to be used as a Building included in the construction program. part of the building process and therefore construction details to the Accredited protection system(AS 3660.1 - 2000). It is to Perimeter and Service Penetration termite treat the building's termite protection as a Installer for pricing etc. The Builder is to Manufacturer's installation instructions. Accredited Installer, as per the be installed by a Manufacturer's

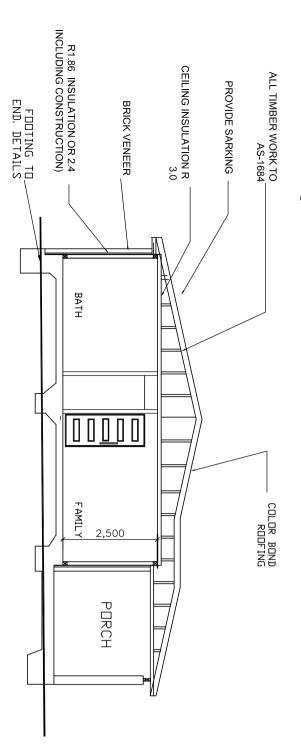

SECTION A-A

SCALE 1:100

## EXTERNAL WALL INSUL CEILING INSULATION ROOF INSULATION COOLING SYSTEM HEATING SYSTEM - STAR RATING HOT WATER - STAR RATING OUTSIDE FIXED CLOTHES DRYING LINE TO BE INSTALED COOKING APPLINCES ALL WINDOWS AND GLAZED DOORS HAVE EAVES THAT PROJECT AT LEAST 450 MILLIMETRES (INCLUDING GUTTER WIDTH); LATION :BRICK VENEER (1.86 OR 2.4 INCLUDING CONSTRUCTION : R 3.5 UP : SARKING OR TWO WIND DRIVEN VENTILATORS :DUCTED ONLY; GAS INSTANTANEOUS : 4 STAR : DUCTED ONLY, ELECTRICAL COOKTOP & OVEN


	<ul> <li>All discrepancies to be brought to the attention of the author.</li> </ul>	REV.	NOTE	Date	
GREENAGRE	<ul> <li>unit scale from grawings, all almenesions to be varified on site before commencement of work.</li> </ul>	Α	ISSUED FOR DA/CC	JUNE 23	
20 PLASTO STREET	preference.				
FRUTUSEU GRANNT FLAI	Engineering.				
	<ul> <li>This drawing is copyright and the property of GHA</li> </ul>				
	NOTES:				
FLOOR PLAN	NEMANNO				

## UGHA EN GINEERING

CIVIL & STRUCTURAL CONSULTANTS Mobile :04133 25 103 FAX: 98966524 589 b Merrylands Road Merrylands NSW 2160 GEORGE H. AZZI B.E. (CIVIL), MIEAust.

Date:			Scale: AS SHOWN	Project No.: 20211554-A
-/ (	4/6	Drawing No.:	CLIENT	DRAWN BY.: G. AZZI

JUNE 23

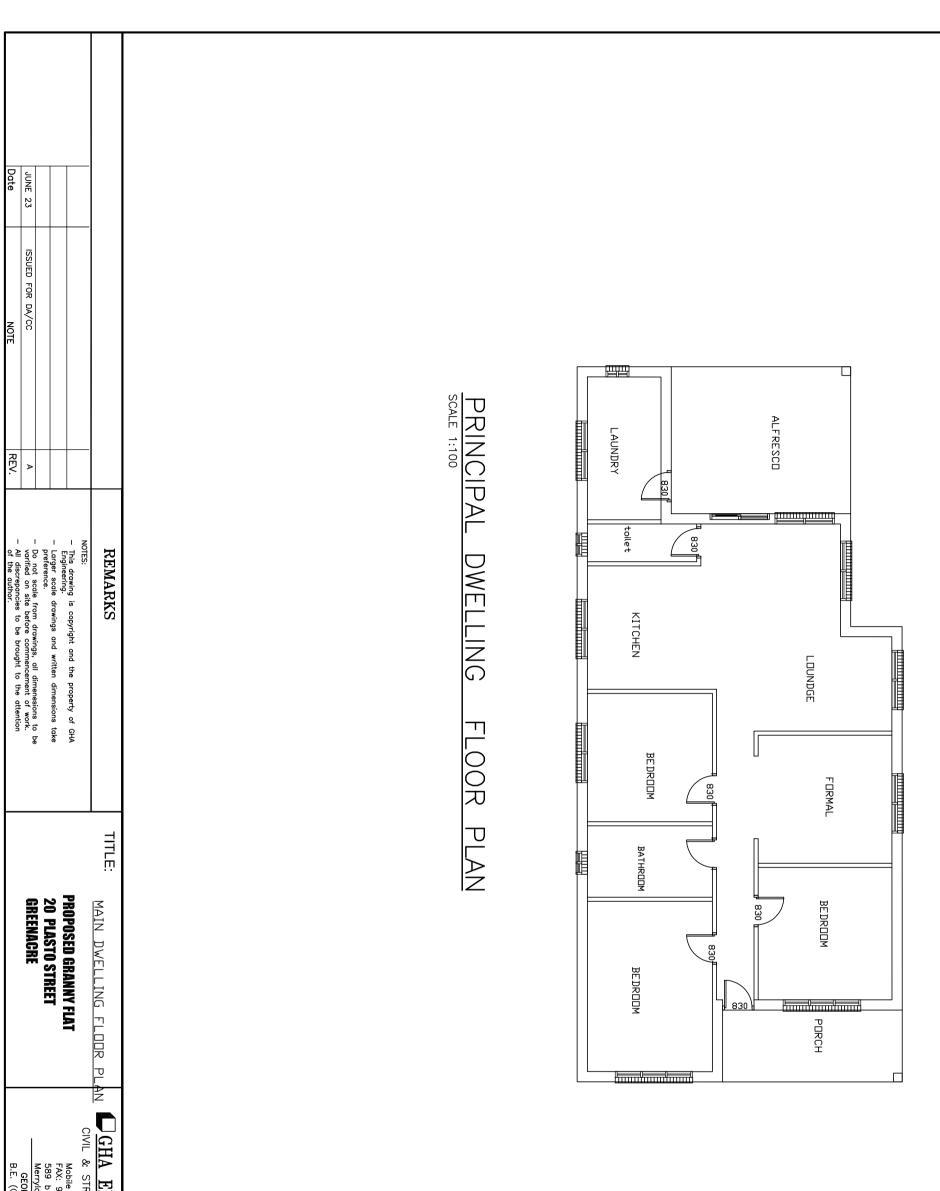

GHA ENGINEERING
CIVIL & STRUCTURAL CONSULTANTS Mobile :04133 25 103 FAX: 98966524 589 b Merrylands Road Merrylands NSW 2160 GEORGE H. AZZI B.E. (CIVIL), MIEAust.

> CLIENT **N** 0::

Date: JUNE 23

Project No.: 20211554-A Scale: AS SHOWN DRAWN BY.: G. AZZI 5/6

